
NA-0824STD_CL

NON ELEVATED 8 ROW x 24'-0" BLEACHER

National Recreation Systems, Inc.

1300-D AIRPORT NORTH OFFICE PARK FORT WAYNE, IN 46825

CS.1	_	COVER SHEET
TD.1	_	BLEACHER SEATING PLAN
FP.1	_	FOUNDATION PLAN
BA.1	_	BLEACHER FRAMING & CLIP PRE-ASSEMBLY
BA.2	_	BLEACHER BRACING LOCATION PLAN
BA.3	_	BLEACHER ASSEMBLY
AP.1	_	ANCHORING PLAN
PF.1		PLANK & FRAMING PLAN
GR.1	_	GUARDRAIL ASSEMBLY

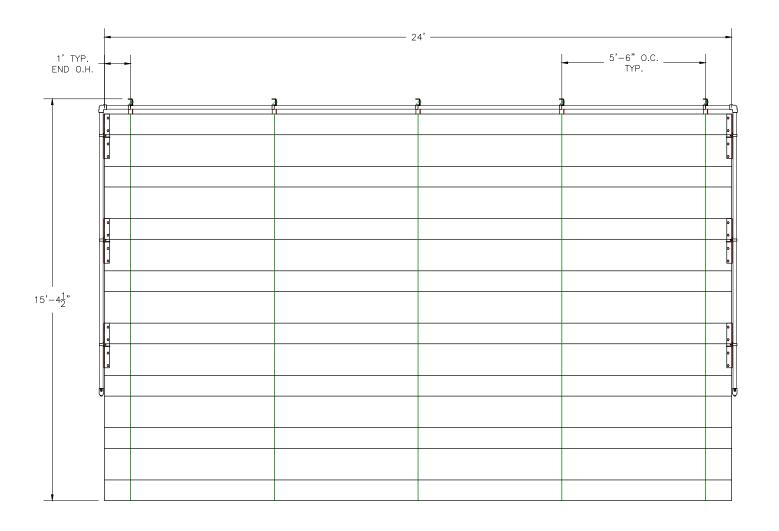

SECTION GROSS ACTUAL NO. OF NET LENGTH SEATS SEATS ROWS SEATS 16.00 16.00 8 128 **NET SEATS** 128 WHEELCHAIR SPACES 128 TOTAL NET SEATING CAPACITY (BASED ON 18" PER SEAT)

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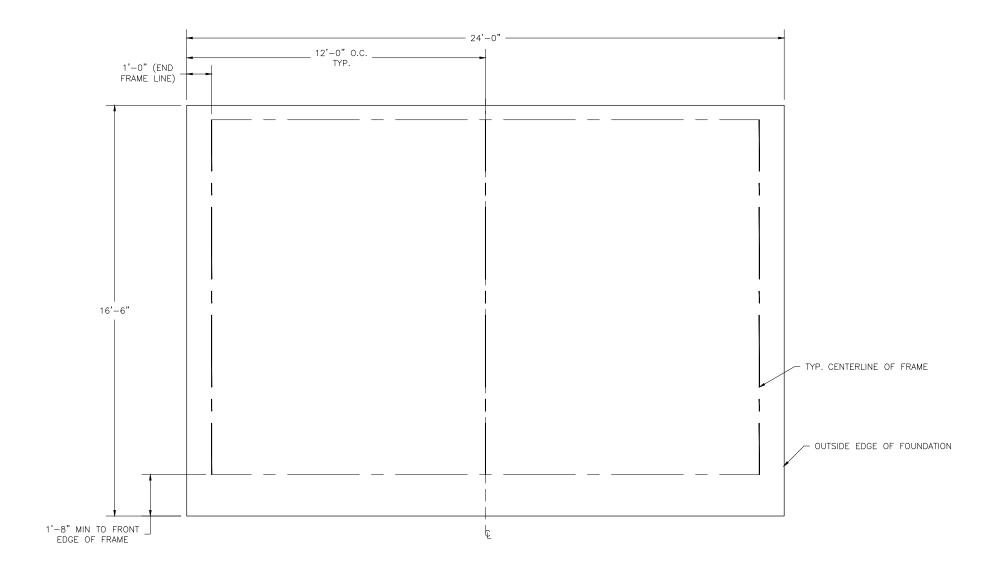
National Recreation Systems, Inc. 1300-D AIRPORT NORTH OFFICE PARK FORT WAYNE, IN 46825

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SCALE:	N.T.S.	APPROVED BY:	DRAWN BY:
DATE:	3/6/17		JIVIL

8 ROW X 24'-0" BLEACHER SEATING PLAN

BLEACHER MODEL #: NA-0824STD_CL



* MINIMUM FOUNDATION AREA SHOWN. DEPENDING ON LOCAL SOIL CONDITIONS, BLEACHER CAN BE INSTALLED ON A CONCRETE PAD OR FOOTERS, OR ATTACHED TO 2x6 TREATED LUMBER GROUND SILLS AND PLACED ON COMPACTED STONE, ASPHALT, OR ANY OTHER SMOOTH, SOLID, LEVEL SURFACE. CONSULT YOUR LOCAL CONCRETE CONTRACTOR TO DETERMINE PROPER CONCRETE SPECIFICATIONS FOR YOUR LOCAL SOIL AND WEATHER-RELATED CONDITIONS. THE BEARING SURFACE MUST BE CAPABLE OF SUPPORTING A MINIMUM OF 660 POUNDS PER LINEAR FOOT. TO MEET LOCAL CODES, BLEACHERS WILL NEED TO BE ANCHORED. ANCHORING SYSTEMS FOR ALL SURFACE TYPES ARE AVAILABLE - CONTACT YOUR BLEACHER SALES REPRESENTATIVE FOR MORE INFORMATION.

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DATE: 3/6/17

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8 ROW X 24'-0" FOUNDATION PLAN

BLEACHER MODEL #: NA-0824STD_CL

DRAWN BY:

JML


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FP. 6






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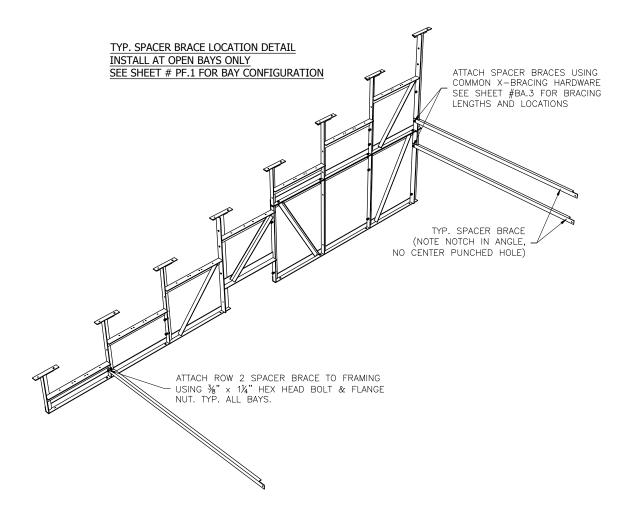
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s.		8 ROW X 24'-	-0" FRAMING & CLIP S	et preparation		

BLEACHER MODEL #: NA-0824STD_CL DRAWING NUMBER:

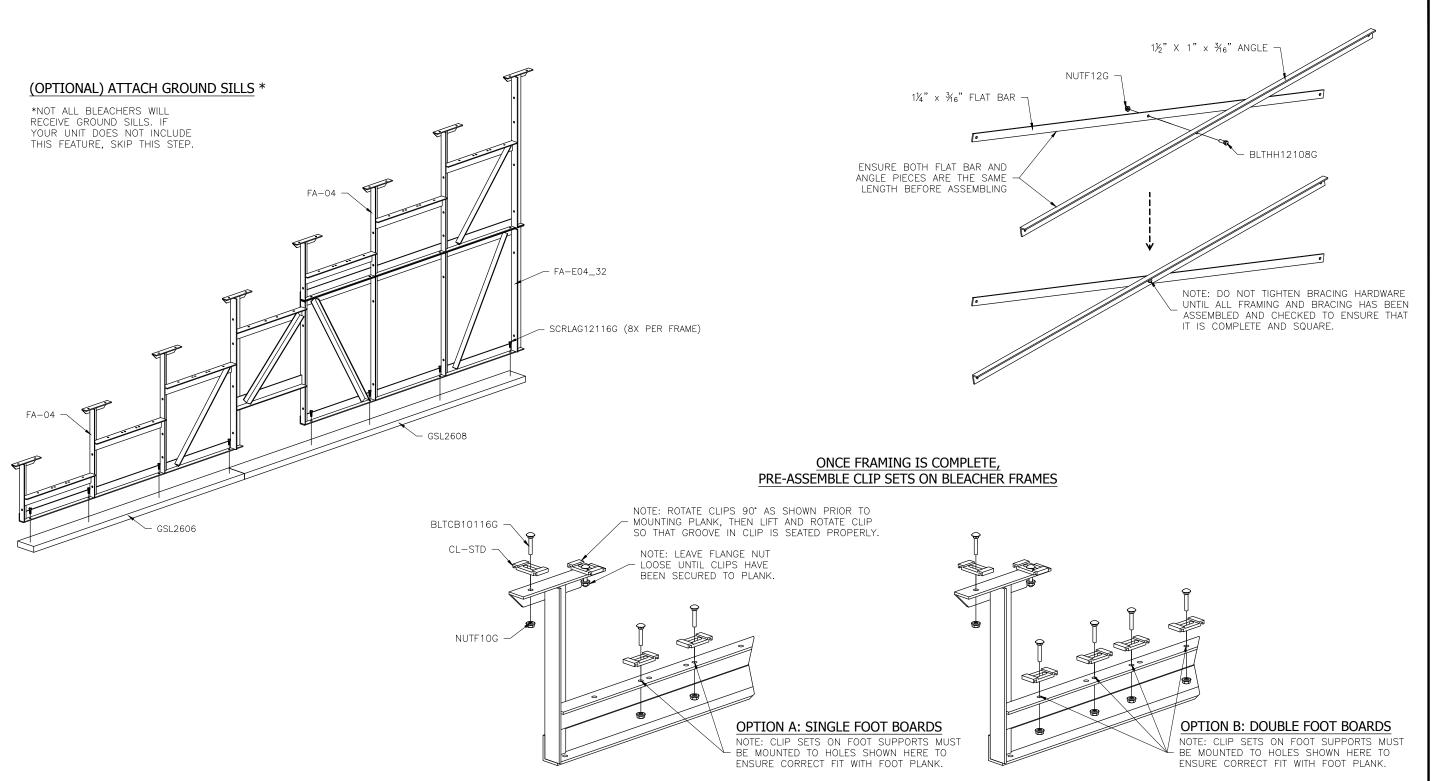



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SCALE: N.T.S.

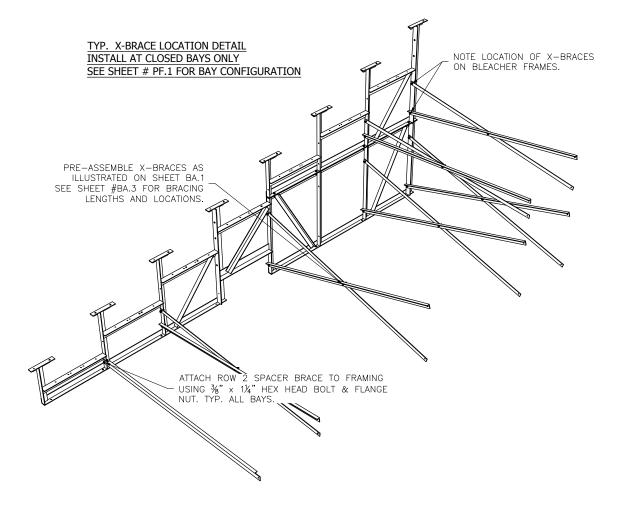DATE: 3/6/17

TITLE:

8 ROW X 24'-0" BLEACHER BRACING LOCATION

BLEACHER MODEL #: NA-0824STD_CL

DRAWN BY:

JML

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DRAWN BY:

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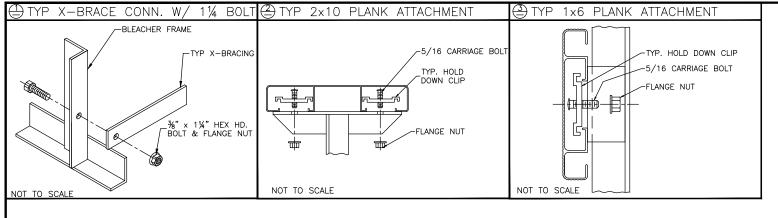
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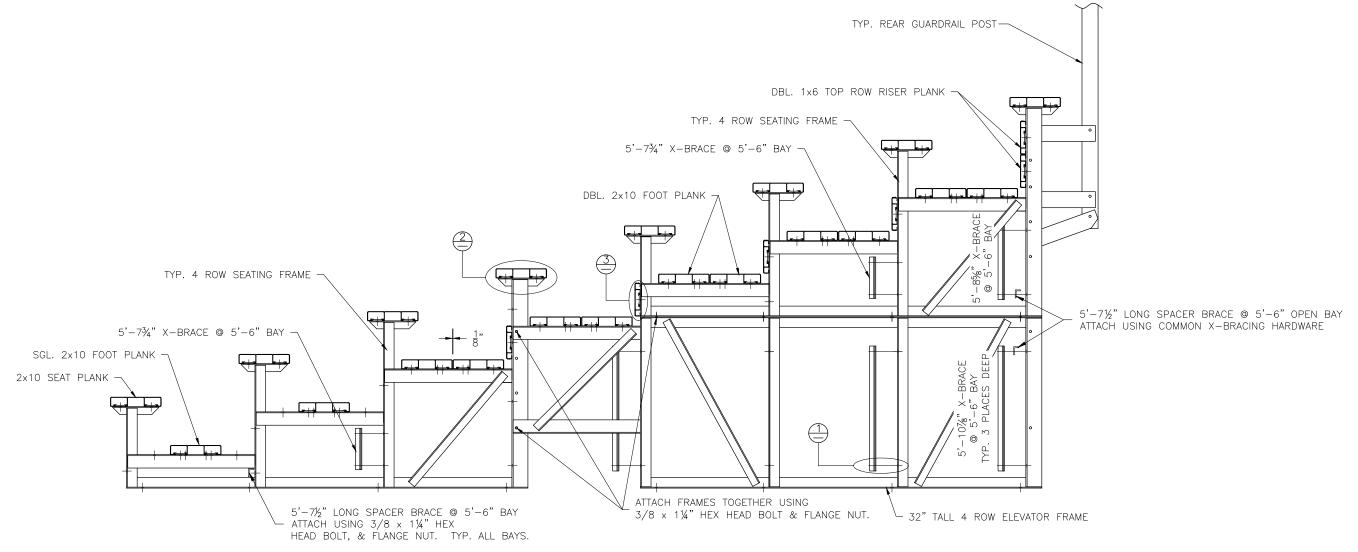
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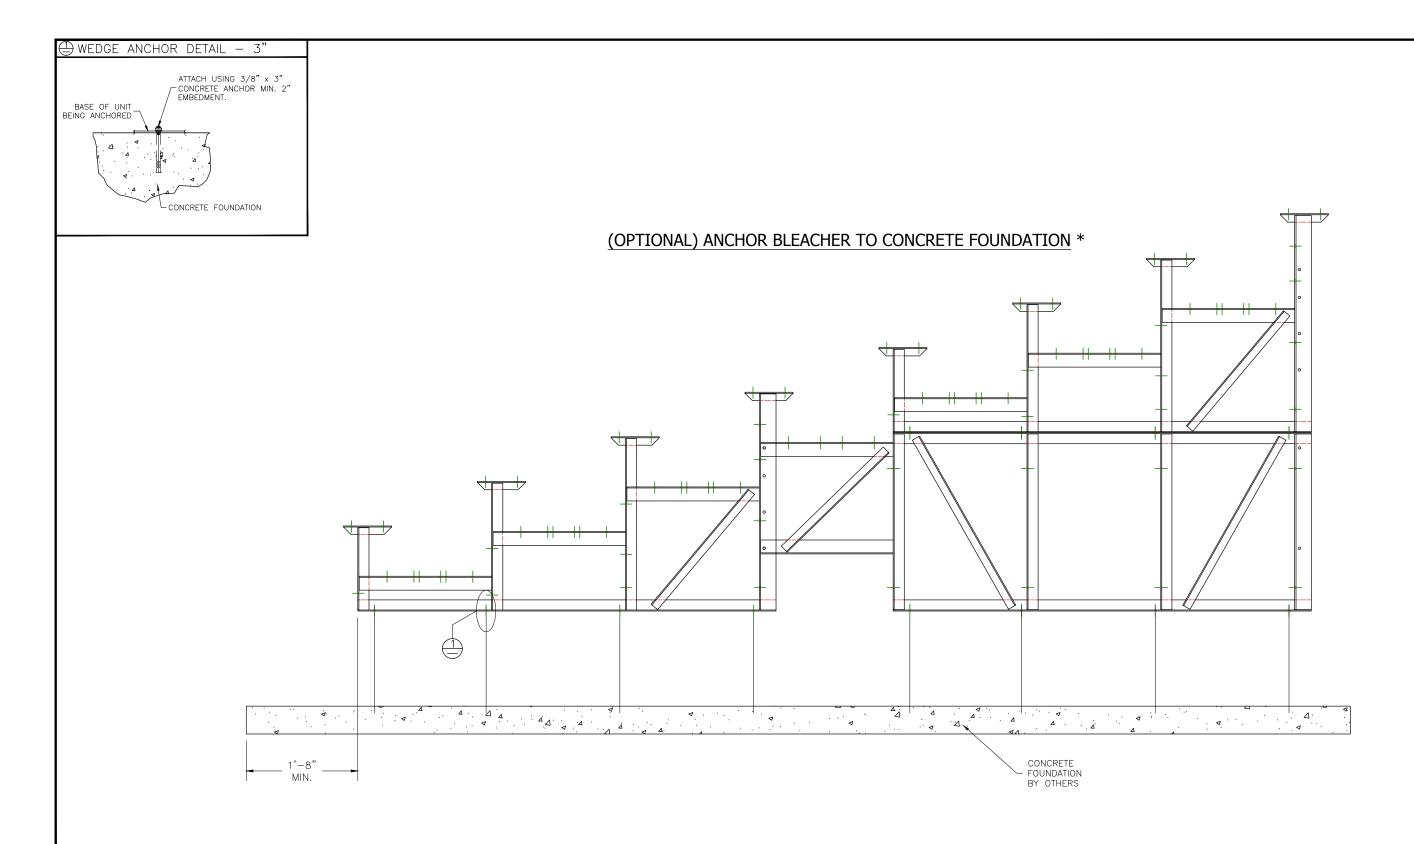




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ı	DATE:	3/6/	/17							JIVIL	
	TITLE:										
3.			8	ROW	Χ	24'-0"	BLEACHER	AS	SEMBLY	(
	BLEACHE	R MODEL	#: ,	.1.4	201	STD_CL			DRAWING N	UMBER:	
			l'	VA-UC	<u> </u>	<u> </u>					BA.3



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DATE:	3/6/17						JIVIL	
TITLE:								
	8	B ROV	N X	24'-0"	ANCHORING	PLAN		
BLEACHER	MODEL #:	30-AI	324S	TD_CL		DRAWING	NUMBER:	AP.1

* CONCRETE WEDGE ANCHORS NOT INCLUDED WITH ALL UNITS. IF USING OTHER ANCHORING SYSTEM, SKIP THIS STEP AND REFER TO INSTRUCTIONS SPECIFIC TO THE ANCHORING SYSTEM PURCHASED FOR YOUR UNIT. SEE PRINT FP.1 (INCLUDED IN THIS PACKET) FOR GENERAL CONCRETE FOUNDATION SPECIFICATIONS.

