
# NB-0324APRF NON ELEVATED ALUMINUM 3 ROW x 24'-0" BLEACHER National Recreation Systems, Inc. 5120 INVESTMENT DRIVE - FORT WAYNE, IN 46808 - BLEACHER SEATING PLAN - FOUNDATION PLAN - ANCHORING PLAN BA.1 - BLEACHER ASSEMBLY - PLANK & FRAMING PLAN

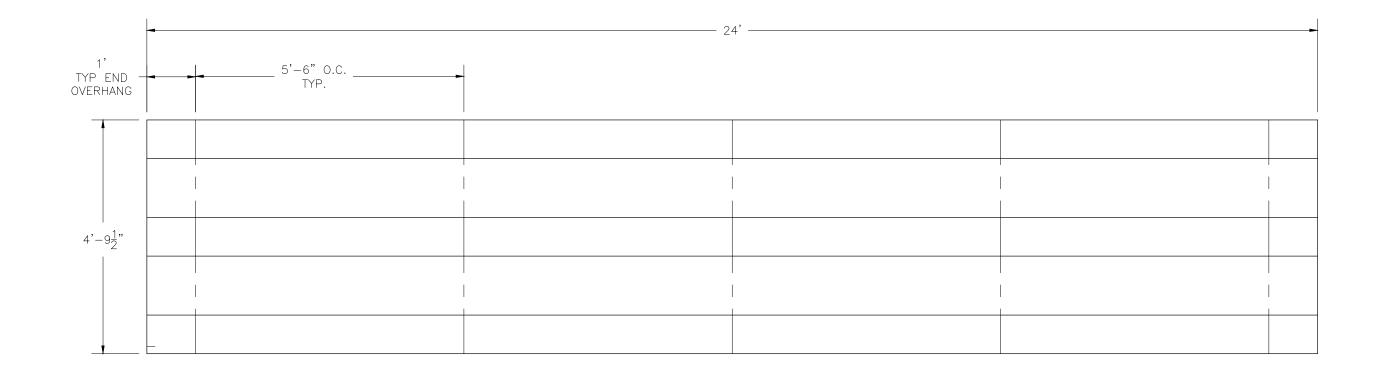


SECTION	GROSS	<b>ACTUAL</b>	NO. OF	NET
LENGTH	SEATS	SEATS	ROWS	SEATS
24	16.00	16.00	3	48
	48			
	0			
TOTAL NET SEATING CAPACITY				48
(BA				

This drawing and all information contained herein is the property of NATIONAL RECREATION SYSTEMS, INC. and is not to be reproduced without express written permission of this manufacturer. We assume no responsibility for unauthorized use of this drawing. National Recreation Systems, Inc. is not responsible for local permits and occupancy requirements.

### National Recreation Systems, Inc.

	5120 INVESTME	NI DRIVE - FOR	I WAYNE,	IN 46808	
SCALE:	N.T.S.	APPROVED BY:		DRAWN BY:	ML
DATE: 0	3/12/15			J	IVIL
TITLE:	,	CEATING			
		SEATING	PLAN		
BLEACHER	MODEL #: NB-(	)324APRF		DRAWING NUME	BER: TD.1

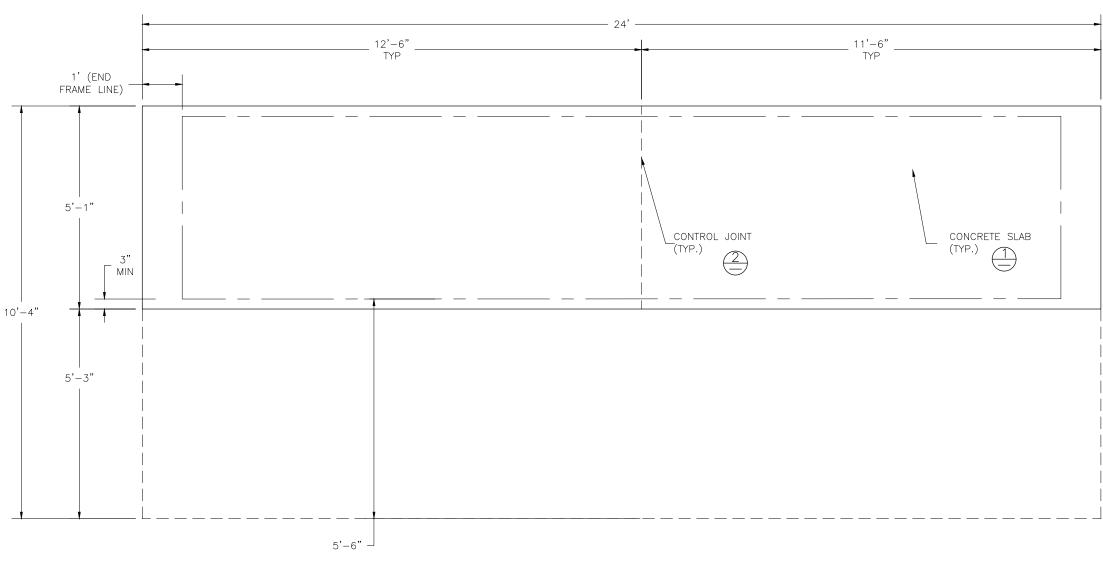

#### CONCRETE FOUNDATION SPECIFICATIONS

#### SCOPE:

Foundation construction is not part of National Recreation Systems, Inc.'s (NRS) scope of work unless noted otherwise in the contract documents. The owner shall review the foundation design with the local code authorities, and coordinate with NRS.

#### FOUNDATION DESIGN & ANCHORS:

- 1) The foundation designs are based on the following:
- a. Minimum presumed soil bearing 1000 psf. b. Bleacher frame dead and live load 700 lbs./ft.
- c. Bleacher frame wind uplift load 250 lbs./ft.

2) Unless otherwise noted on the drawings the bleacher frames shall be attached to the concrete with 3/8" dia. x 3" wedge type expansion anchors. The anchors shall be embedded a minimum of 1 3/4" into the concrete.


#### CONCRETE SPECIFICATIONS:

- 1) All concrete construction shall be in accordance with ACI 318-08.
- 2) All concrete shall have a minimum 28-day strength of Fc=3000 psi.
- 3) A 1/4" bituminous expansion joint material shall be placed between strip and slab foundations when adjacent to each
- 4) The depressions in the top of the foundations between high spots shall not exceed 5/16" below a 10-foot long straightedge. The 10-foot straightedge method used to measure foundation flatness shall be in accordance with Section of ACI 302.1R-04 "Guide for Concrete Floor and Slab Construction".

#### CONCRETE SLAB SPECIFICATIONS:

- 1) Concrete slab shall have a minimum thickness of 5" (NRS, Inc. recommends, and some areas may require 6" thickness) and placed on 4" of compacted gravel or compacted sand sub-base.
- 2) NRS, Inc. recommends that the concrete slab be reinforced with 6x6-W2.1xW2.1 welded wire fabric at 1½" concrete cover from the top. In lieu of welded wire fabric, 2" XOREX by Ribbon Technology Corporation or equal corrugated steel fibers applied at a rate of 50-lbs./Cubic Yard may be used. Nylon or polypropylene fiber are not recommended.
- 3) Crack control joints shall be sawed into slab to form approximate square patterns. The maximum spacing for control joints shall not exceed 12'-6", unless shown otherwise on this drawing. The bleacher frames shall not be set on control joints. The designer shall contact NRS to coordinate joint spacing requirements with the specific bleacher design.
- 4) The slab may be sloped a maximum of 1/8 inch per foot for drainage. The maximum overall out of level slope for the slab perpendicular to the seats (front to rear) shall not exceed 2" and parallel to the seats (end to end) shall not exceed 4".


NOTE: CONCRETE PAD DOES NOT INCLUDE WHEELCHAIR EGRESS IN FRONT OF BLEACHER. ADD 5'-3" IN OVERALL DEPTH TO ACCOMMODATE WHEELCHAIRS.

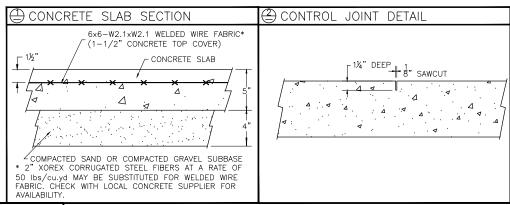

This drawing and all information contained herein is the property of NATIONAL RECREATION SYSTEMS, INC. and is not to be reproduced without express written permission of this manufacturer. We assume no responsibility for unauthorized use of this drawing. National Recreation Systems, Inc. is not responsible for local permits and occupancy requirements

### National Recreation Systems, Inc.


5120 INVESTMENT DRIVE - FORT WAYNE, IN 46808 APPROVED BY: N.T.S JML DATE: 03/12/15 TITLE: FOUNDATION PLAN DRAWING NUMBER: NB-0324APRF

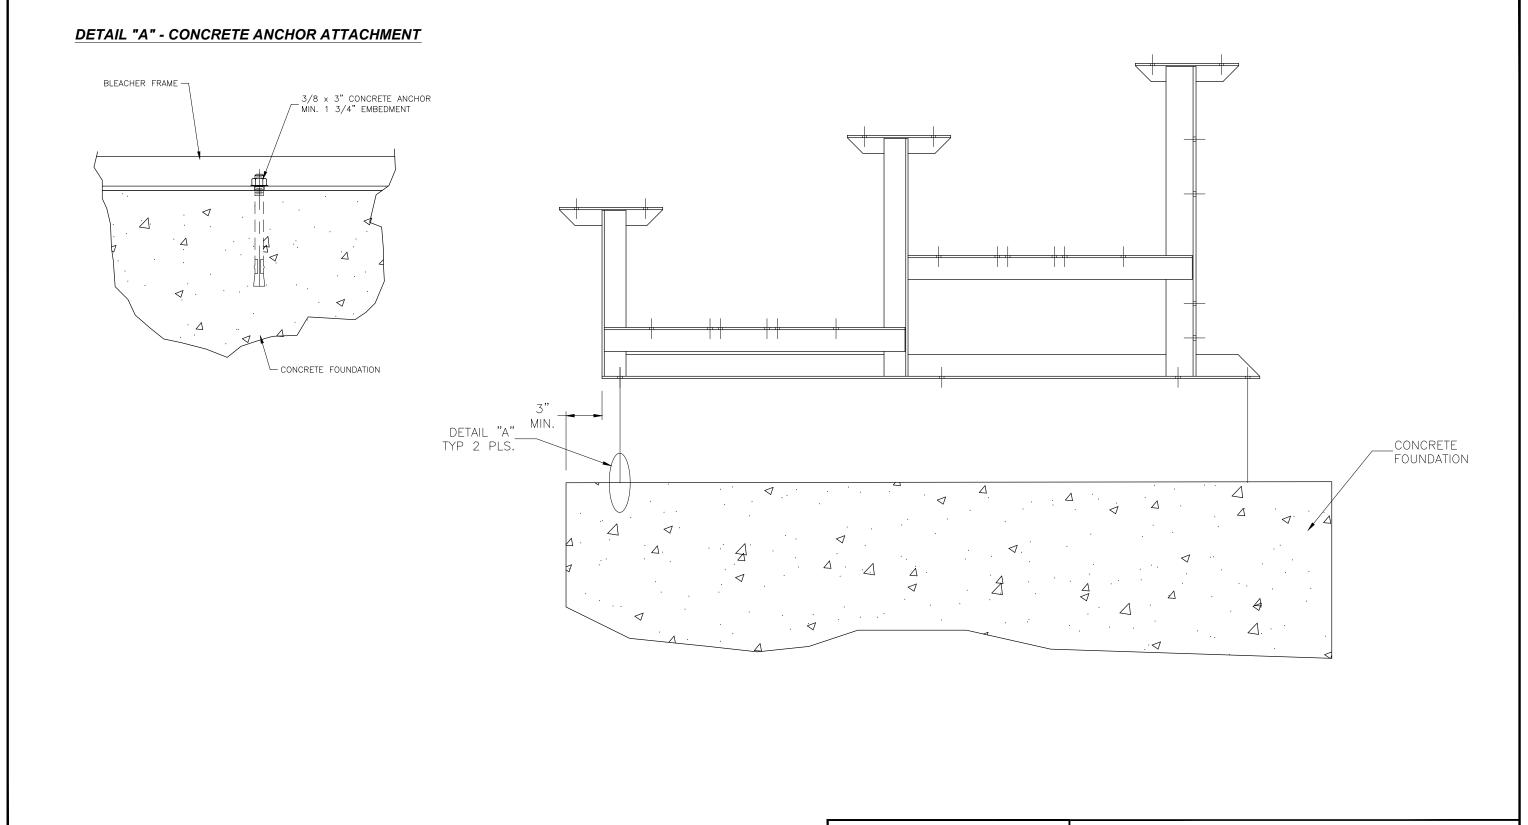


This drawing and all information contained herein is the property of NATIONAL RECREATION SYSTEMS, INC. and is not to be reproduced without express written permission of this manufacturer. We assume no responsibility for unauthorized use of this drawing. National Recreation Systems line is not reprossible. Recreation Systems, Inc. is not responsible for local permits and occupancy requirements.

## National Recreation Systems, Inc. 5120 INVESTMENT DRIVE - FORT WAYNE, IN 46808

OTES INVESTIMENT BILLYE TOTAL WATTE, IN 1888					
SCALE: N.T.S.	APPROVED BY:	DRAWN BY:			
DATE: 03/12/15		JML			
TITLE:	ANCHORING PLAN				
BLEACHER MODEL #: NR-	0.324APRF	DRAWING NUMBER: Δ □ 1			

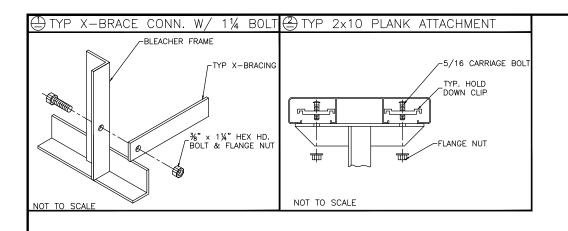


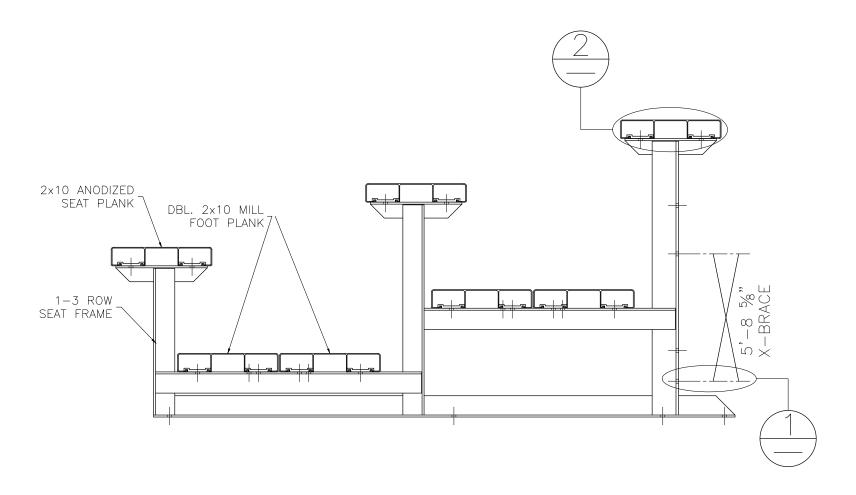


This drawing and all information contained herein is the property of NATIONAL RECREATION SYSTEMS, INC. and is not to be reproduced without express written permission of this manufacturer. We assume no responsibility for unauthorized use of this drawing. National Recreation Systems line is not reprossible. Recreation Systems, Inc. is not responsible for local permits and occupancy requirements.

## National Recreation Systems, Inc. 5120 INVESTMENT DRIVE - FORT WAYNE, IN 46808

SCALE: N.T.C. APPROVED BY:						
	SCALE: N.T.S.	APPROVED BY:		DRAWN B		
	DATE: 03/12/15				JML	
	TITLE:	BLEACHER	ASSEMBLY			
	BLEACHER MODEL #: NR-(	)324APRF		DRAWING	NUMBER:	RΔ 1

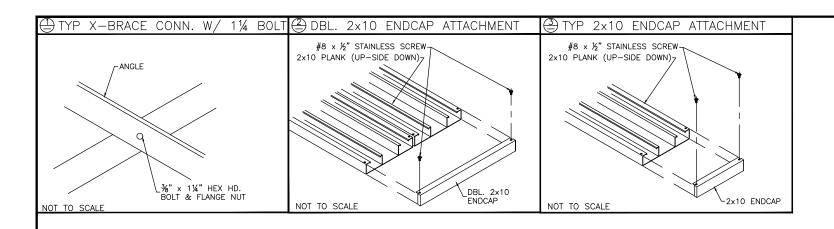

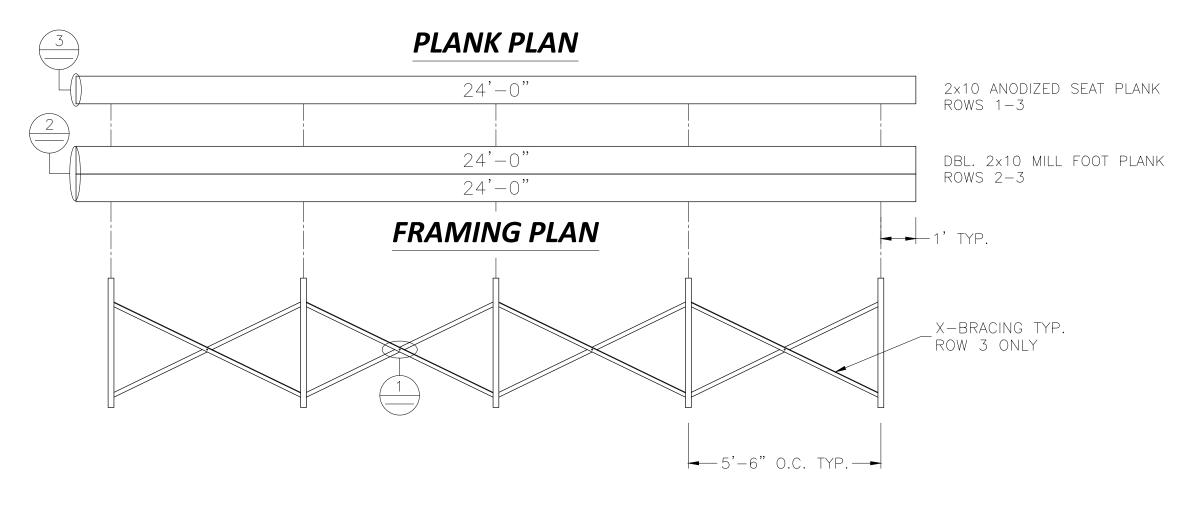

This drawing and all information contained herein is the property of NATIONAL RECREATION SYSTEMS, INC. and is not to be reproduced without express written permission of this manufacturer. We assume no responsibility for unauthorized use of this drawing. National Recreation Systems, Inc. is not responsible for local permits and occupancy requirements.

# National Recreation Systems, Inc. 5120 INVESTMENT DRIVE - FORT WAYNE, IN 46808

1								
I	scale: N.T.S.	APPROVED	BY:			DRAWN E		
ĺ	DATE: 03/12/15						JML	
I	TITLE:		0.	FRAMING				
l		PLAINK	α	FRAMING	PLAIN			
	BLEACHER MODEL #: NB-(	)324APF	RF			DRAWING	NUMBER:	PF.1